V.A. DAVID KELLY, APPLICANT

PUBLIC HEARING to consider **Certificate of Appropriateness No. 642** – A request for a façade remodel and exterior improvements to an existing building located at 19 North Fifth Street (formerly Oscar's Mexican Restaurant). The existing building shares the 5,900 square-foot parcel (APN: 0171-121-10-0000) with Historic Resource No. 33 located at 24 E. State Street. The project qualifies for exemption from environmental review in accordance with Section 15331 (Historical Resource Restoration/Rehabilitation) and Section 15301 (Existing Facilities) of the California Environmental Quality Act Guidelines.

HISTORIC AND SCENIC PRESERVATION MEETING: February 3, 2022

Planner: Sean Reilly, Senior Planner

PROCEDURE FOR PUBLIC HEARING

- 1. Chairperson declares the meeting open as a public hearing.
- 2. Chairperson calls upon staff for report.
- 3. Chairperson calls for questions/comments from members of the Commission.
- 4. Chairperson calls upon applicant, or its representative, for comments/testimony.
- 5. Chairperson calls for comments/questions/testimony from members of the public (3 minutes per speaker).
- 6. Chairperson calls upon the applicant, or representative, for rebuttal comments (5 minutes).
- 7. Chairperson closes the public hearing.
- 8. Commission considers the motion(s) and votes.

SYNOPSIS

1. Historic Designation: The parcel that the subject building is located on contains

the Buster Building, which is Historic Resource No. 33 located at 24-30 E. State Street. The subject building was constructed on the same parcel to the rear of the Buster

Building fronting on N. Fifth Street.

2. Existing Land Use: The site is currently developed with two commercial/retail

buildings facing State Street and a vacant restaurant building

(formerly Oscar's Mexican Food) facing N. Fifth Street.

3. Historic and Scenic Preservation Commission submittal dates:

(A) Date Submitted: October 27, 2021

(B) Date Accepted as Complete: January 10, 2022

(C) Historic and Scenic Preservation

Commission Meeting: February 3, 2022

4. Attachments:

- (A) Location Map
- (B) Architectural plans
- (C) Resolution No. 2022-006, with Conditions of Approval

PROPOSAL

The applicant is proposing to renovate the façade of an existing structure located at 19 N. Fifth Street in downtown Redlands (Attachment A - Location Map). This parcel also contains Historic Resource No. 33, the Buster Building located at 24-30 E. State Street which is one of the oldest buildings still standing in the downtown area of Redlands. The subject site is a rectangular corner lot with alley access on the south side. The adjacent Buster building is oriented to the north fronting on Orange Street. The proposed project fronts onto N. Fifth Street, located behind the Buster Building and although the buildings are attached, there is no internal connectivity.

The proposal includes a remodel of the exterior of the building at 19 N. Fifth Street on both the Fifth Street and alley facing frontages as shown on the project plans and elevations included as Attachment B. Modifications to the exterior are listed below.

Southern Elevation (Alley Facing)

- Outdoor seating area enclosed by a 42-inch-high guard rail painted Pantone "Shale) with small planters.
- New aluminum storefront door accessing the outdoor seating area.
- New aluminum storefront window facing the alley
- Existing masonry will remain in place

Eastern Elevation (N. Fifth Street Facing)

- Replacement of the existing exterior wall
- Plaster wall finish painted Pantone "Bellini"
- Decorative formed metal parapet cap
- Five semi-circle/arched transom windows
- Two 8' x 9' bi-fold glass patio doors
- Aluminum Storefront Doors
- Decorative plaster arches and accents
- Outdoor seating area enclosed by a 42-inch-high guard rail painted Pantone "Shale") with small planters.

BACKGROUND

The parcel, as a whole, was designated as Historic Resource No. 33 in 1988. The focus of the Historic Resource Designation was the front portion of the parcel, containing the Buster building. The adjacent Buster building was originally two separate brick buildings, located at 24-26 East State Street and at 28-30 East State Street, constructed in 1896 and 1887, respectively. These buildings are the original buildings on the parcel. In 1900, these two buildings were connected at the second level into one building.

The Buster building's exterior has been remodeled several times and in 1987, the brick exterior was stuccoed over. The staff report for the historic designation of the site notes that this was not recommended as a historic property based upon its appearance, which had been repeatedly changed and was no longer original. Instead, the building was designated based upon its status as the oldest building in downtown, as well as its association with the Scipio Craig, the first editor of the Citrograph newspaper. The first occupant of the building at 28 E State Street was the newspaper, which operated there for two years. The Citrograph was the first newspaper in Redlands and it still operates today. Scipio Craig is noted as a person who significantly contributed to the culture, history and development of the City of Redlands. He is important to Redlands history because of his early enthusiastic promotion of the City. He built the Citrograph into one of the premier newspapers in Southern California. It was a major source of information on citrus, horticulture, water, and tourist information. He was active in three state press associations and held the presidency of two of them.

The portion of the lot that is developed with subject structure, under review of this Certificate of Appropriateness application, includes a single-story building that was most recently occupied by Oscar's Mexican restaurant. The building is currently vacant and adjoins the Buster building, to the south, on the same parcel. This portion of the parcel appears to have been developed between 1900 and 1908, based on Sanborn Fire Insurance maps of the site. In 1981, (prior to the parcel's historic designation) a major façade remodel was completed for Oscar's Mexican restaurant, which substantially altered the façade of this portion of the building to reflect that of the restaurant's theme. The result of this remodel is the existing façade that is present today.

ANALYSIS

A) Zoning

The property is located within the C-3 (General Commercial) District. The purpose of the C-3 zone is to provide a central location, accessible from all areas of the city and surrounding areas, for the purchase of primary shoppers' goods. Restaurants and eating establishments are permitted uses in this zone. The scope of work includes a

façade remodel of an existing restaurant building and the proposed future use of the building is consistent with the permitted uses in the zone. There are no changes to the footprint of the building, as such, development standards such as lot coverage, and setbacks remain unchanged and will not alter the site's conformity with the underlying zoning district. The site, as designed, is compatible with development standards of the C-3 District.

B) Secretary of the Interior Standards and Guidelines

As a Certified Local Government, the City of Redlands implements the Secretary of the Interior's Standards for the Treatment of Historic Properties with Guidelines for Preserving, Rehabilitating, Restoring & Reconstructing Historic Building (hereinafter, "Secretary of Interior Standards") when applicable and appropriate. Although the subject structure at 19 N. Fifth Street is not mentioned in the historic designation documents for the parcel, the adjacent structure to which it is connected and located on the same parcel as, the Buster Building, at 24-30 East State Street, is Historic Landmark No. 33 on the City's list of historic resources.

The National Park Service has a Preservation Brief on "Rehabilitating Historic Storefronts" (https://www.nps.gov/tps/how-to-preserve/briefs/11-storefronts.htm) that is applicable and appropriate to assist staff's evaluation of the proposal in this case. A portion of this document discusses designing replacement storefronts and states:

"If the original or significant storefront no longer exists or is too deteriorated to save, undertake a contemporary design which is compatible with the rest of the building in scale, design, materials, color and texture..."

"Where an original or significant storefront no longer exists and no evidence exists to document its early appearance, it is generally preferable to undertake a contemporary design that retains the commercial "flavor" of the building. The new storefront design should not draw attention away from the historic building with its detailing but rather should respect the existing historic character of the overall building."

"A new design that copies traditional details or features from neighboring buildings or other structures of the period may give the building a historical appearance which blends in with its neighbors but which never, in fact, existed. For this reason, use of conjectural designs, even if based on similar buildings elsewhere in the neighborhood or the availability of different architectural elements from other buildings or structures, is generally not recommended."

The Secretary of the Interior's Guidelines for Designing Replacement Storefronts as well as the project's consistency with these guidelines are listed below.

1. Scale: Respect the scale and proportion of the existing building in the new storefront design.

The existing building is 16 feet tall. The remodeled façade as proposed does not increase the height of the structure or the footprint of the building maintaining the existing scale and relationship to the Buster building and the original construction.

2. Materials: Select construction materials that are appropriate to the storefronts; wood, cast iron, and glass are usually more appropriate replacement materials than masonry which tends to give a massive appearance.

The project proposes to use a plaster wall finish that is similar to the stucco of the adjacent buster building and includes metal window frames, and several glass windows. The existing exterior masonry on the alley facing side of the building will remain in place.

3. Cornice: Respect the horizontal separation between the storefront and the upper stories. A cornice or fascia board traditionally helped contain the store's sign.

The building does not have an upper story, therefore this portion of this guideline does not apply. The existing façade of the building includes a sign band area, which was created in the 1981 remodel. The proposed façade maintains an open space above the arched windows that will serve as a future sign location.

4. Frame: Maintain the historic planar relationship of the storefront to the facade of the building and the streetscape (if appropriate). Most storefront frames are generally composed of horizontal and vertical elements.

The true historic appearance of the building is unknown to staff. As modified in 1981, the façade included little variation in depth and no roofline projection. The entry doors were recessed into an archway and awnings were included above arched windows. As proposed, the facade will not include significant projections. All of the windows and doors are topped with decorative plaster arches and arched, semicircle windows, providing vertical design elements without changing the roofline. Two large windows on the Fifth Street side of the building are large bifold doors which can be opened up to the interior of the building, which will create the appearance of additional depth.

5. Entrances: Differentiate the primary retail entrance from the secondary access to

HISTORIC AND SCENIC PRESERVATION COMMISSION CERTIFICATE OF APPROPRIATENESS NO. 642 FEBRUARY 3, 2022 PAGE 6

upper floors. In order to meet current code requirements, out-swinging doors generally must be recessed. Entrances should be placed where there were entrances historically, especially when echoed by architectural detailing (a pediment or projecting bay) on the upper stories.

The building does not contain an upper floor and all doorways will be required to meet the current building code. The original location of the entrances to the building are unknown. The proposed remodel adds a new door to the south of the existing doorway. In the location of the existing doorway, a new 8-foot wide bifold door is proposed which will provide access to the proposed patio seating area. Any construction or use of outdoor patio area would be subject to receiving approval of separate permits or agreements for activities occurring in the public right-of-way, and this is reflected in the conditions of approval.

Windows: The storefront generally should be as transparent as possible. Use of glass in doors, transoms, and display areas allows for visibility into and out of the store.

The proposed restaurant façade includes ground level windows, large bifold doors and arched transom windows over the main windows and doors. The proposed windows include two large bifold doors which will allow for visibility into and out of the restaurant when opened. On the alley side of the restaurant, the applicant is proposing a new glass storefront door as well as the placement of a new window facing the alley.

7. Secondary Design Elements: Keep the treatment of secondary design elements such as graphics and awnings as simple as possible in order to avoid visual clutter to the building and its streetscape.

No graphics or awnings are currently proposed. Secondary design elements that should be considered are the two outdoor seating areas, which would require approval of separate permits and use agreements, per conditions of approval. While these seating areas are not structural in nature, they do present changes to the outward appearance of the building and the streetscape. As proposed, the outdoor seating areas would be delineated by a 42-inch metal guardrail and small planters. These planters and guard rails are relatively simple in appearance and add some visual interest to the streetscape.

In relation to the Secretary of the Interior Standards for Designing Replacement Storefronts, the project is generally consistent. The original facade no longer exists and the original design is not documented. The applicant is proposing a contemporary design which is compatible, yet differentiated from the adjacent Buster building as well as others in the immediate area and does not propose conjectural features or include

excessive detail, which could detract from or draw attention from the primary resource on the property which fronts onto E. State Street.

C) City of Redlands Historic and Scenic Preservation Design Manual

The project will be consistent with the City's Historic and Scenic Preservation Design Manual. The proposed rehabilitation project will not alter or permanently remove any of the characteristic features of the architectural style of the historic resource present on the property. All improvements will be located to the rear of the historic structures and only be partially visible from visible from State Street. The view of the historic resource from State Street would be unimpaired and unchanged, as none of the improvements will block the resource from view and all changes are proposed to be located on Fifth Street to the rear of the designated structure. The design of the new facade uses similar stucco materials and façade treatments to what is currently on the Buster Building, while also differentiating the new portion from the existing resource.

D) Summary

The proposed rehabilitation project, with the incorporation of standard conditions of approval, will not adversely affect or change the historical resource, nor its context. The scope of work is consistent with the Redlands Municipal Code, Secretary of the Interior's Standards, and the City's Historic and Scenic Preservation Manual, and the Citywide Context Statement.

ENVIRONMENTAL REVIEW

The proposed project is Class 3 exempt from the requirements of the California Environmental Quality Act's (CEQA) guidelines pursuant to Section 15331 (Historical Resource Restoration/Rehabilitation) and Section 15301 (Existing Facilities) of the California Environmental Quality Act Guidelines.

STAFF RECOMMENDATION

Staff recommends that the Historic and Scenic Preservation Commission approve Certificate of Appropriateness No. 642, subject to the recommended conditions of approval.

MOTION

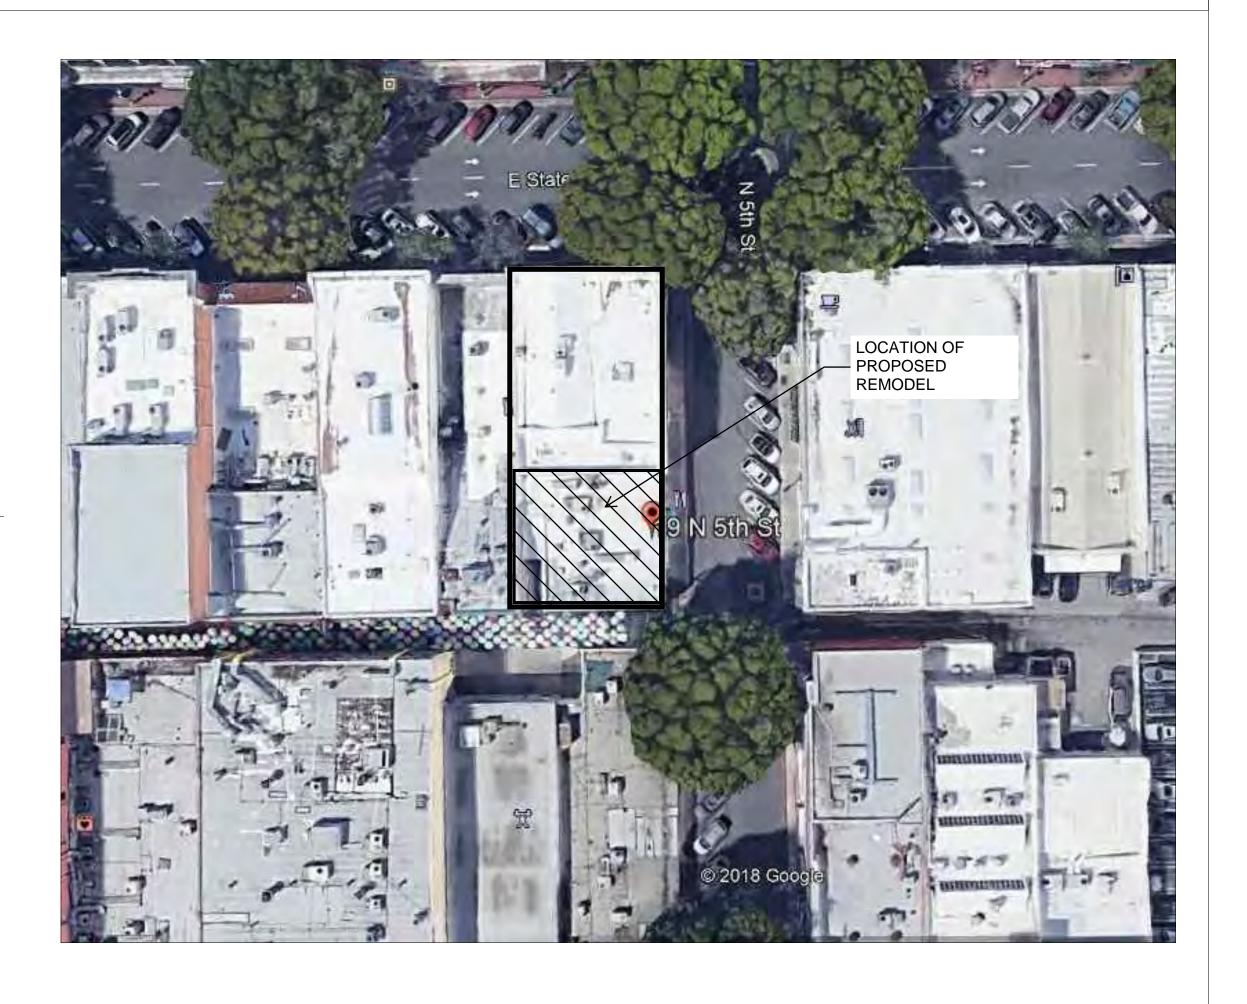
If the Historic and Scenic Preservation Commission deems it appropriate, staff recommends the following motion:

HISTORIC AND SCENIC PRESERVATION COMMISSION CERTIFICATE OF APPROPRIATENESS NO. 642 FEBRUARY 3, 2022 PAGE 8

"I move that the Historic and Scenic Preservation Commission adopt Resolution No. 2022-06, finding that the project is exempt from further environmental review pursuant to Section 15331 (Historical Resource Restoration/Rehabilitation) and Section 15301 (Existing Facilities) of the California Environmental Quality Act Guidelines, and approving Certificate of Appropriateness No. 642, subject to conditions of approval.



SITE PLAN



INTERIOR REMODEL BRUNCH CLUB

19 N. 5TH STREET REDLANDS, CA. 92373



REDLANDS, CALIFORNIA 9237 Ph. (909) 499-0058

onsent of Higginson Architects. Inc.

5TI ND:

APPROVALS:

REVISIONS:

DATE: DATE:

CHECKED BY: D.W.H. DRAWN BY: DATE: 10/21/21

SHEET TITLE:

TITLE SHEET

SHEET NO

BUILDING CODES:

- 2016 BUILDING STANDARDS ADMINISTRATIVE CODE, PART 1, TITLE 24 C.C.R. * • 2016 CALIFORNIA BUILDING CODE (CBC), PART 2, TITLE 24 C.C.R. (2015 INTERNATIONAL BUILDING CODE VOLUMES 1-2 AND 2016 CALIFORNIA
- AMENDMENTS) • 2016 CALIFORNIA ELECTRICAL CODE (CEC), PART 3, TITLE 24 C.C.R.
- (2014 NATIONAL ELECTRICAL CODE AND 2016 CALIFORNIA AMENDMENTS) • 2016 CALIFORNIA MECHANICAL CODE (CMC), PART 4, TITLE 24 C.C.R. (2015 UNIFORM MECHANICAL CODE AND 2016 CALIFORNIA AMENDMENTS)
- 2016 CALIFORNIA PLUMBING CODE (CPC), PART 5, TITLE 24 C.C.R. (2016 UNIFORM PLUMBING CODE AND 2016 CALIFORNIA AMENDMENTS)
- 2016 CALIFORNIA ENERGY CODE (CEC), PART 6, TITLE 24 C.C.R. * 2016 CALIFORNIA FIRE CODE, PART 9, TITLE 24 C.C.R.
- (2016 INTERNATIONAL FIRE CODE AND 2016 CALIFORNIA AMENDMENTS) 2016 CALIFORNIA GREEN BUILDING STANDARDS CODE, PART 11, TITLE 24 C.C.R.
- 2016 CALIFORNIA REFERENCED STANDARDS, PART 12, TITLE 24 C.C.R.
- TITLE 19 C.C.R., PUBLIC SAFETY, STATE FIRE MARSHAL REGULATIONS 2013 ASME A17.1 SAFETY CODE FOR ELEVATORS AND ESCALATORS

PARTIAL LIST OF APPLICABLE STANDARDS

	NFPA 13	AUTOMATIC FIRE SPRINKLER SYSTEMS	2016	EDITIO
	NFPA 14	STANDPIPE AND HOSE SYSTEMS	2016	EDITIO
	NFPA 17	DRY CHEMICAL EXTINGUISHING SYSTEMS	2013	EDITIO
	NFPA 17a	WET CHEMICAL EXTINGUISHING SYSTEMS	2013	EDITIO
	NFPA 20	STATIONARY PUMPS FOR FIRE PROTECTION	2016	EDITIO
	NFPA 22	WATER TANKS FOR PRIVATE FIRE PROTECTION	2013	EDITIO
	NFPA 24	PRIVATE FIRE MAINS & THEIR APPURTENANCES	2016	EDITIO
	NFPA 25	STANDARD FOR INSPECTION, TESTING AND MAINTENANCE	2017	EDITIO
		OF WATER-BASED FIRE PROTECTION SYSTEMS		
	NFPA 72	NATIONAL FIRE ALARM & SIGNALING CODE	2016	EDITIO
_	NFPA 80	FIRE DOORS AND OTHER OPENING PROTECTIVES	2016	EDITIO
	NFPA 92	STANDARD FOR SMOKE CONTROL SYSTEMS	2015	EDITIO
	NFPA 253	CRITICAL RADIANT FLUX OF FLOOR COVERING SYSTEMS	2015	EDITIO
	NFPA 2001	CLEAN AGENT FIRE EXTINGUISHING SYSTEMS	2015	EDITIO
	ICC 300	ICC STANDARDS ON BLEACHERS, FOLDING AND	2015	EDITIO
		TELESCOPING SEATING, AND GRAND STANDS		
	UL 300	FIRE TESTING OF FIRE EXTINGUISHING SYSTEMS	2015	EDITIO
		FOR PROTECTION OF RESTAURANT COOKING AREAS		
	UL 464	AUDIBLE SIGNAL APPLIANCES	2016	EDITIO
	UL521	HEAT DETECTORS FOR FIRE PROTECTIVE	2016	EDITIO
		SIGNALING SYSTEMS		

REFERENCE CODE SECTION FOR NFPA STANDARDS-2016 CBC (SFM) CHAPTER 35. SEE CHAPTER 35 FOR STATE OF CALIFORNIA AMENDMENTS TO NFPA STANDARDS.

BUILDING SUMMARY

1STORY BUILDING

OCCUPANCY:

CONST TYPE: **VB NON-SPRINKLERED** 0171-121-10-0-000

TOTAL FLOOR AREA:

1,499 SF OCCUPANCY LOAD: 39 (DINING) 5 (STAFF)

PROJECT TEAM:

PROPERTY OWNER:

YUNG KYU PARI 19 N. 5TH STREET REDLANDS, CA. 92373

APPLICANT:

NECTAR INTERNATIONAL INC. 721 NEVAEDA STREET. SUITE 404 REDLANDS, CA. 92373 PH. 909/809-1267 E-MAIL: dave@nectarclothing.com

ARCHITECT: DAVID W. HIGGINSON, AIA 38868 BUTTERFLY DRIVE YUCAIPA, CA. 92399 PH. 909/499-0058 E-MAIL: dhigginson.hai@gmail.com

MEP/STRUCTURAL DESIGN: STEVEN PAUL MURRAY, ARCHITECT 1177 IDAHO STREET, SUITE 200 REDLANDS, CA. 92374 PH. 909/884-7660

GENERAL NOTES:

FURNISH ALL ITEMS REQUIRED FOR PROPER EXECUTION AND COMPLETION


GENERAL CONSTRUCTION NOTES:

- THESE DRAWINGS INDICATE THE GENERAL SCOPE OF THE PROJECT IN TERMS OF ARCHITECTURAL DESIGN CONCEPT, THE DIMENSIONS OF THE BUILDING, THE MAJOR ARCHITECTURAL ELEMENTS AND THE TYPE OF STRUCTURAL, MECHANICAL, ELECTRICAL SYSTEMS. ON THE BASIS OF THE GENERAL SCOPE INDICATED OR DESCRIBED, THE CONTRACTOR SHALL FURNISH ALL ITEMS REQUIRED FOR THE PROPER EXECUTION AND COMPLETION OF THE WORK.
- ALL CONSTRUCTION AND MATERIALS SHALL BE AS SPECIFIED AND AS REQUIRED BY THE CURRENT EDITION OF THE UBC, LOCAL CODES, AND AUTHORITIES.
- 3. THE CONTRACTOR SHALL VERIFY ALL DIMENSIONS AND SITE CONDITIONS BEFORE COMMENCING WORK. SHOULD A DISCREPANCY FROM THE CONTRACT DOCUMENTS APPEAR IN THE SPECIFICATIONS OR DRAWINGS, OR IN THE WORK DONE BY OTHERS, THAT AFFECTS ANY WORK, NOTIFY THE ARCHITECT AT ONCE FOR INSTRUCTION ON HOW TO PROCEED. IF THE CONTRACTOR PROCEEDS WITH THE WORK AFFECTED WITHOUT INSTRUCTION FROM THE ARCHITECT. THE CONTRACTOR SHALL CORRECT ANY RESULTING DAMAGE OR DEFECT TO THE SATISFACTION OF THE ARCHITECT. SHOULD A CONFLICT OCCUR BETWEEN DRAWINGS AND SPECIFICATIONS, OR WHERE DETAIL REFERENCES ON CONTRACT DRAWINGS HAVE BEEN OMITTED, THE CONTRACTOR IS DEEMED TO HAVE ESTIMATED THE MOST EXPENSIVE MATERIALS AND CONSTRUCTION METHOD INVOLVED, UNLESS A WRITTEN DECISION FROM THE ARCHITECT HAS BEEN OBTAINED WHICH DESCRIBES AN ALTERNATE METHOD AND/OR
- THE CONTRACTOR SHALL CONFINE HIS/HER OPERATIONS ON THE SITE TO AREAS PERMITTED BY THE CITY. THE WORK SHALL BE DONE IN ACCORDANCE WITH ALL APPLICABLE LAWS, LOCAL ORDINANCES, PERMITS, AND THE CONTRACT DOCUMENTS. THE JOB SITE SHALL BE MAINTAINED IN A CLEAN. ORDERLY CONDITION AND FREE OF DEBRIS AND LITTER. CONTRACTOR SHALL REMOVE ALL TRASH AND DEBRIS AS A RESULT OF HIS OPERATION IMMEDIATELY UPON COMPLETION OF EACH PHASE OF HIS WORK.
- ALL MATERIAL STORED ON THE SITE SHALL BE PROPERLY STACKED AND PROTECTED TO PREVENT DAMAGE AND DETERIORATION UNTIL USE. FAILURE TO PROTECT MATERIALS MAY BE CAUSE FOR REJECTION OF THE WORK.
- 6. ALL PATCHING, REPAIRING, AND REPLACING OF MATERIALS AND SURFACES CUT OR DAMAGED IN EXECUTION OF WORK, SHALL BE DONE WITH APPLICABLE MATERIALS SO THAT SURFACES REPLACED SHALL MATCH SURROUNDING SURFACES.
- NO PORTION OF THE WORK REQUIRING A SHOP DRAWING OR SAMPLE/STRIKE-OFF SUBMITTAL SHALL BE COMMENCED UNTIL THE SUBMITTAL HAS BEEN APPROVED BY THE ARCHITECT AND/OR OWNER. ALL SUCH PORTIONS OF THE WORK SHALL BE IN ACCORDANCE WITH APPROVED SHOP DRAWINGS AND SAMPLES/STRIKE-OFFS.
- 8. DIMENSIONS ALL DIMENSIONS SHALL HAVE PREFERENCE OVER SCALE.
 - ALL DIMENSIONS ARE TO BE ROUGH. CEILING HEIGHT DIMENSIONS ARE FROM FINISH FLOOR SLAB TO FINISH

SCOPE OF WORK:

- IT IS THE INTENT OF THIS CONTRACT TO CONSTRUCT INTERIOR MPROVEMENTS IN UNDER THIS CONTRACT, BUT NOT LIMITED TO, IS AS FOLLOWS:
- 1, DEMOLITION OF EXISTING WALLS AND WINDOWS
- CONSTRUCTION OF NEW WALLS AND DOORS
- NEW FLOORING AND FINISHES AS NOTED.
- MODIFY EXISTING CEILING AS REQUIRED TO CONSTRUCT NEW.
- NEW HVAC SYSTEMS
- NEW LIGHTING AND ELECTRICAL SYSTEMS
- STRUCTURAL MODIFICATIONS TO EXISTING BUILDING.
- NEW KITCHEN EQUIPMENT AND CASEWORK
- CONSTRUCT NEW EXTERIOR FENCING AND GATE FOR OUTDOOR DINING AREA.

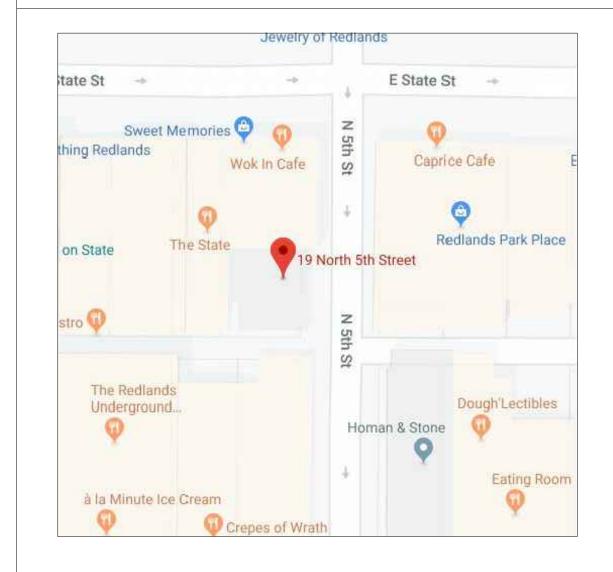VICINITY MAP:



SHEET INDEX:

TITLE SHEET

A1.0 FLOOR PLAN

A2.0 REFLECTED CEILING PLAN EXTERIOR ELEVATIONS / WALL SECTIONS A3.0 A4.0 KITCHEN EQUIPMENT PLAN

LEGENDS, NOTES & SCHEDULES

PANEL SCHEDULES, SCHEDULES, & SINGLE LINE DIAGRAM ELECTRICAL PANEL SCHEDULES

E2.0 ELECTRICAL POWER PLAN

ELECTRICAL LIGHTING |PLAN E4.0 **ELECTRICAL ROOF PLAN**

ENERGY COMPLIANCE ENERGY COMPLIANCE

> **EQUIPMENT SCHEDULE, LEGEND, & NOTES** MECHANICAL SPECIFICATIONS

MECHANICAL ENERGY COMPLIANCE FORMS MECHANICAL ENERGY COMPLIANCE FORMS MECHANICAL FLOOR PLAN

MECHANICAL ROOF PLAN MECHANICAL DETAILS MECHANICAL DETAILS M3.1

LEGEND, NOTES & SCHEDULES P.02 **NOTES & SCHEDULES**

P.03 SPECIFICATIONS WASTE & VENT PLAN

DOMESTIC PLUMBING SUPPLY PLAN GAS SUPPLY FLOOR PLAN GAS SUPPLY ROOF PLAN

P6.0 PLUMBING DETAILS PLUMBING DETAILS

EQUIPMENT FLOOR PLAN EQUIPMENT SCHEDULE

STRUCTURAL GENERAL NOTES S0.2 STRUCTURAL GENERAL NOTES FOUNDATION PLAN

S2.0 **CEILING FRAMING PLAN** S2.1 ROOF FRAMING PLAN SD1 STRUCTURAL DETAILS







PANTONE Shale 19-3903 TCX



This plan / design may not be copied, reproduced or assigned to any third party without the written consent of Higginson Architects, Inc.

Copyright 2021

CONSULTANT:

CLIENT

BRUNCH CLUB INTERIOR REMODEL 19 N. 5TH STREET

ADDDOVA

EVISIONS:

DATE:

DATE:

DATE:

CHECKED BY: D.W.H.

ECKED BY: D.W.H. DRAWN BY

SHEET TITLE:

RENDERING & COLOR SELECTION

SHEET NO:



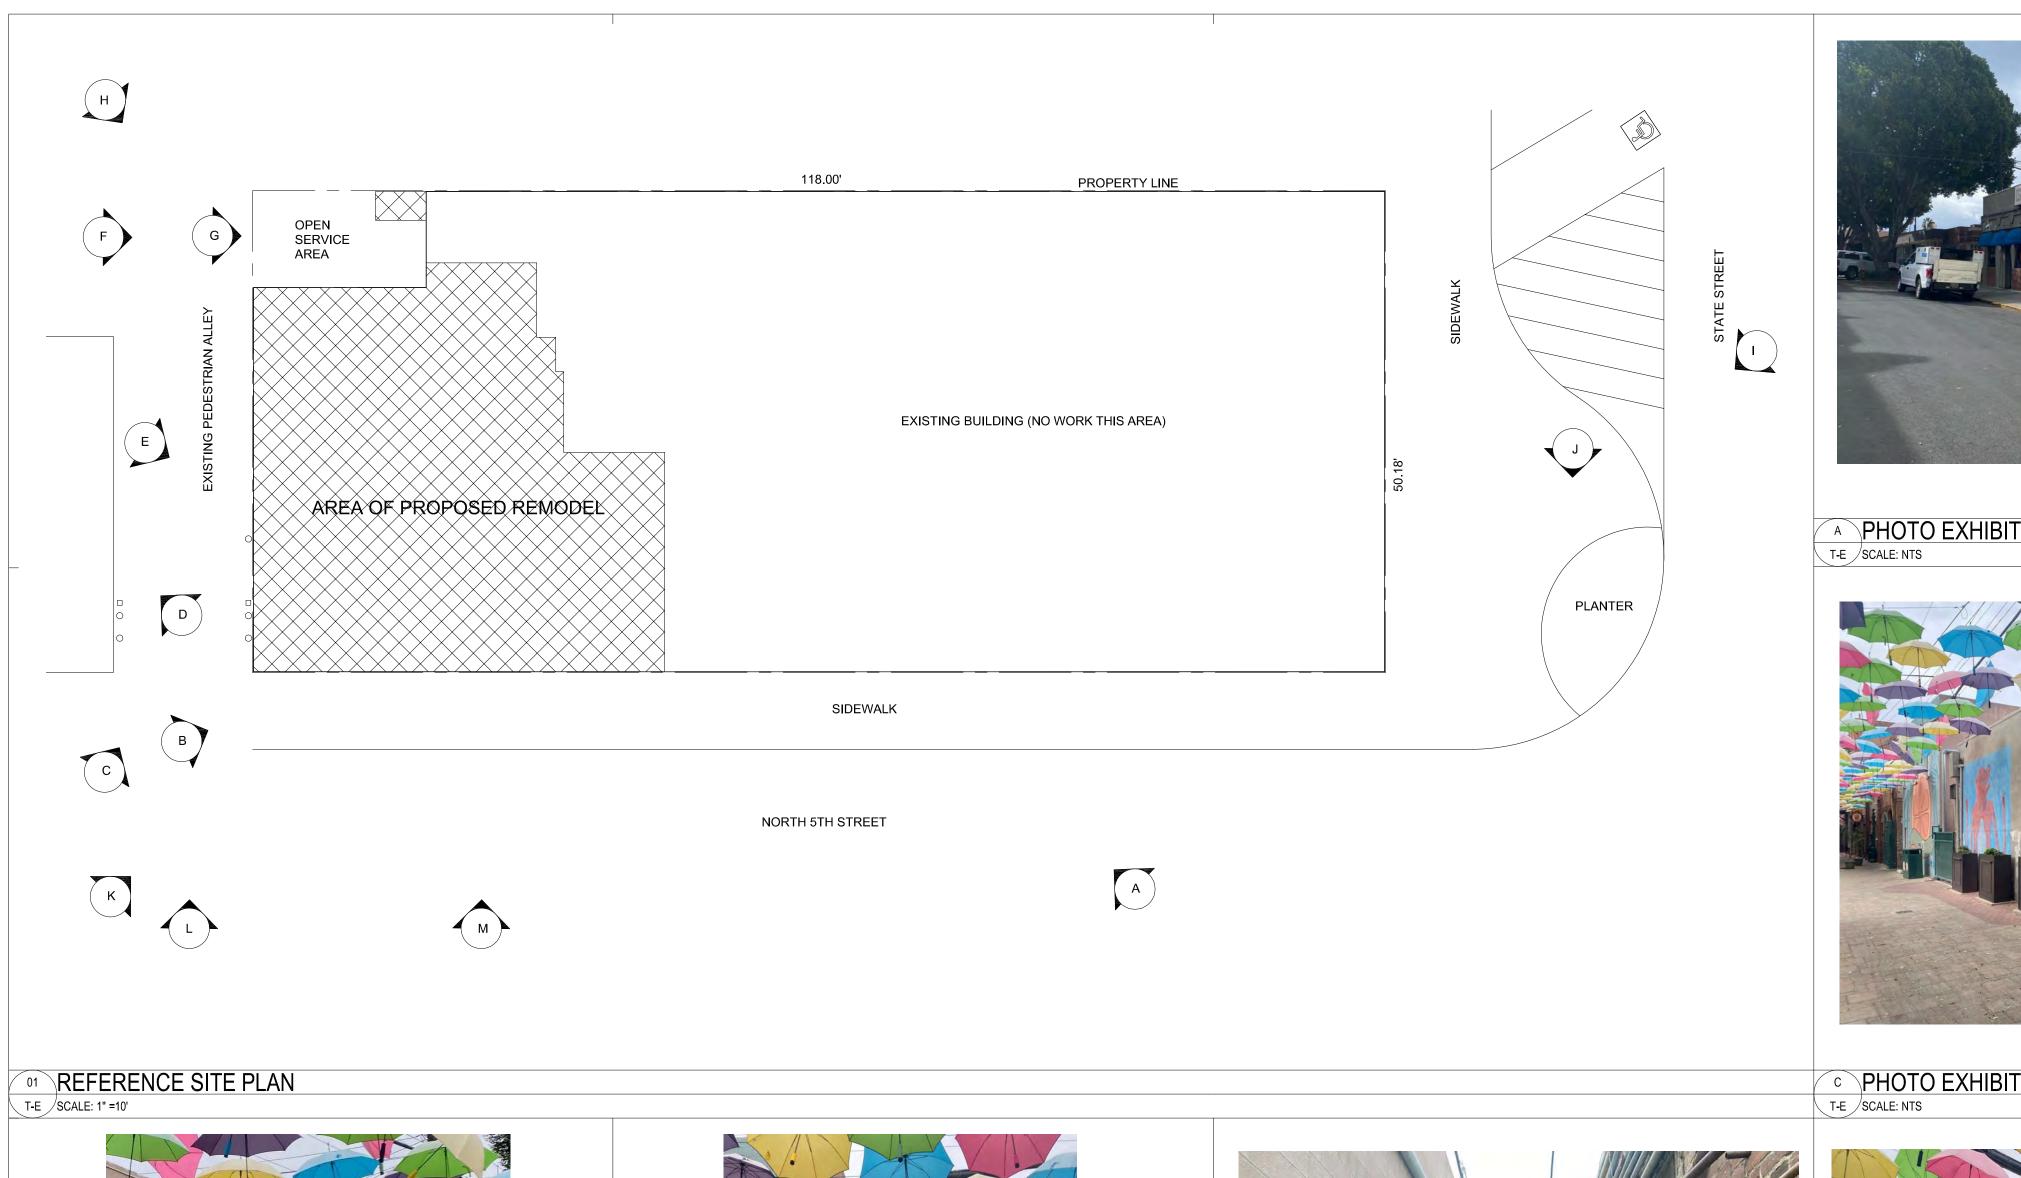






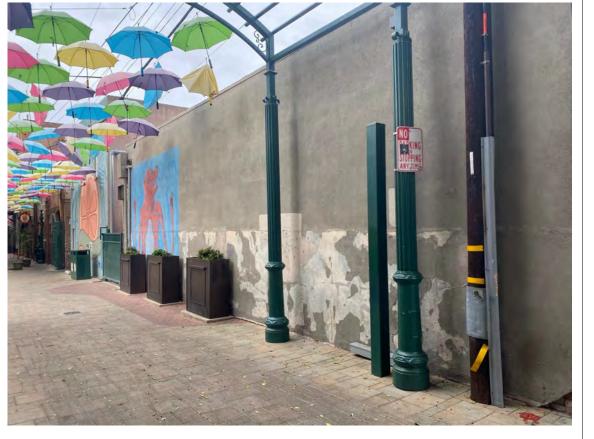


PHOTO EXHIBIT T-E SCALE: NTS

PHOTO EXHIBIT

PHOTO EXHIBIT
T-E SCALE: NTS

T-E SCALE: NTS






This plan / design may not be copied, reproduced or assigned to any third party without the written consent of Higginson Architects, Inc.

Copyright 2021

CONSULTANT:

CLIENT:

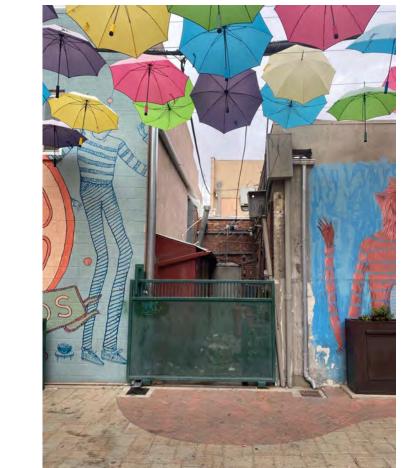BRUNCH CLUB
INTERIOR REMODEL
19 N. 5TH STREET
REDLANDS, CA. 92373











APPROVALS:

REVISIONS:


SHEET TITLE:

CHECKED BY: D.W.H. DRAWN BY: DATE: 9/21/21

SITE PLAN &

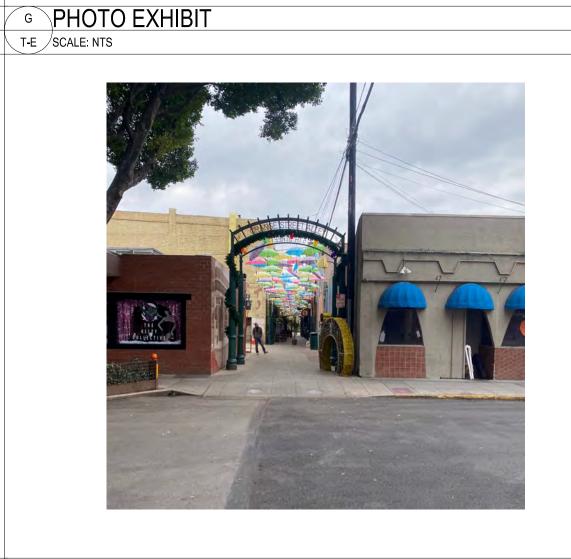PHOTO EXHIBITS







J PHOTO EXHIBIT
T-E SCALE: NTS

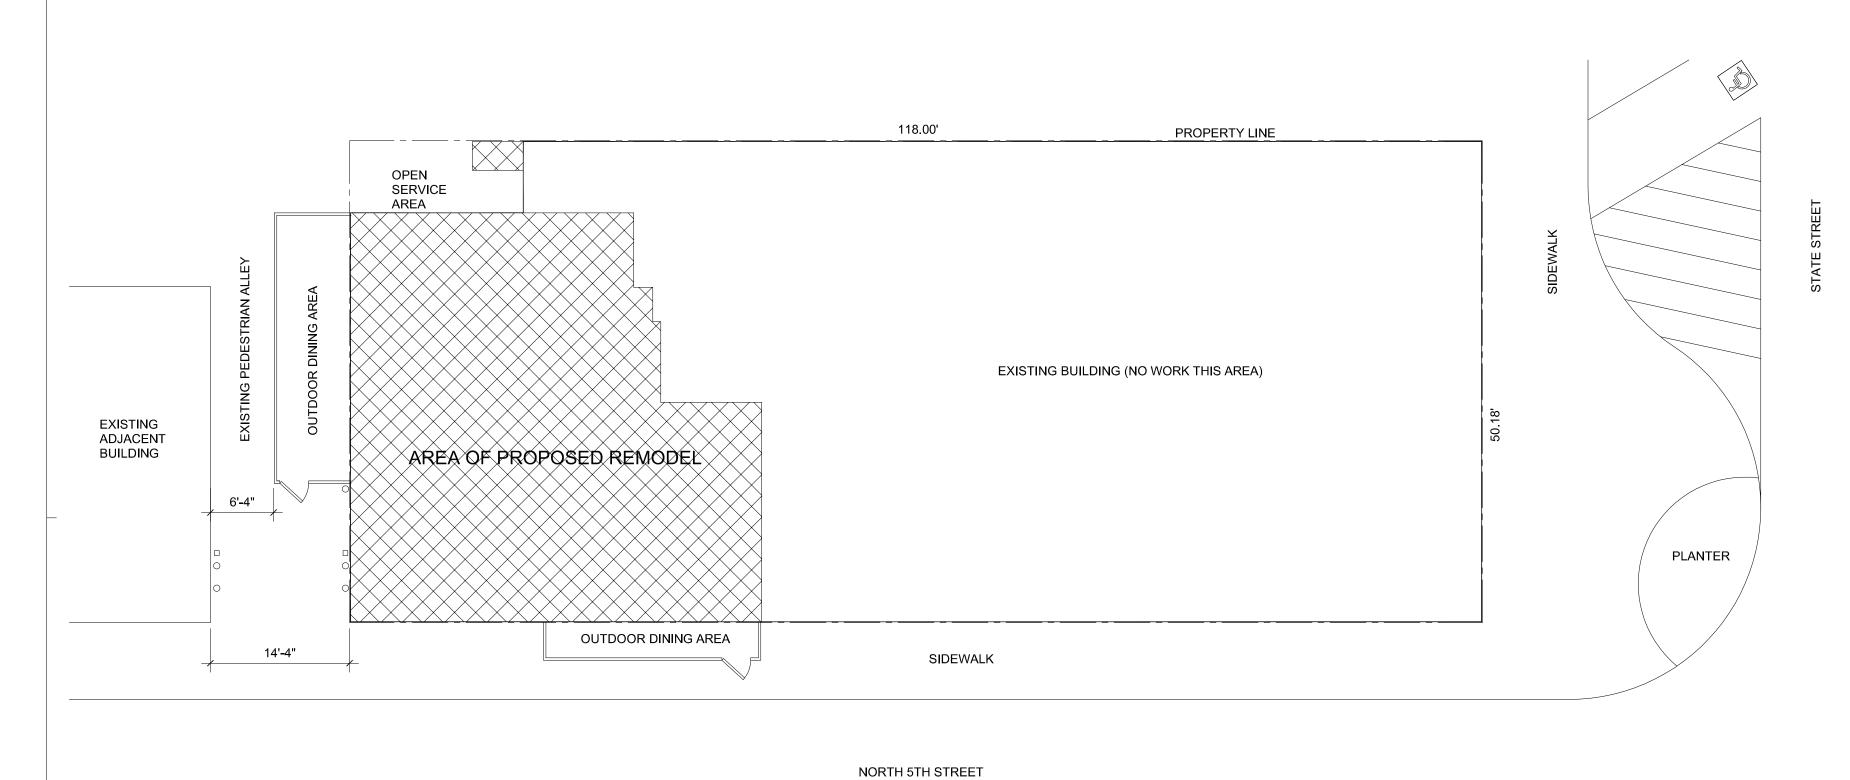
E PHOTO EXHIBIT
T-E SCALE: NTS

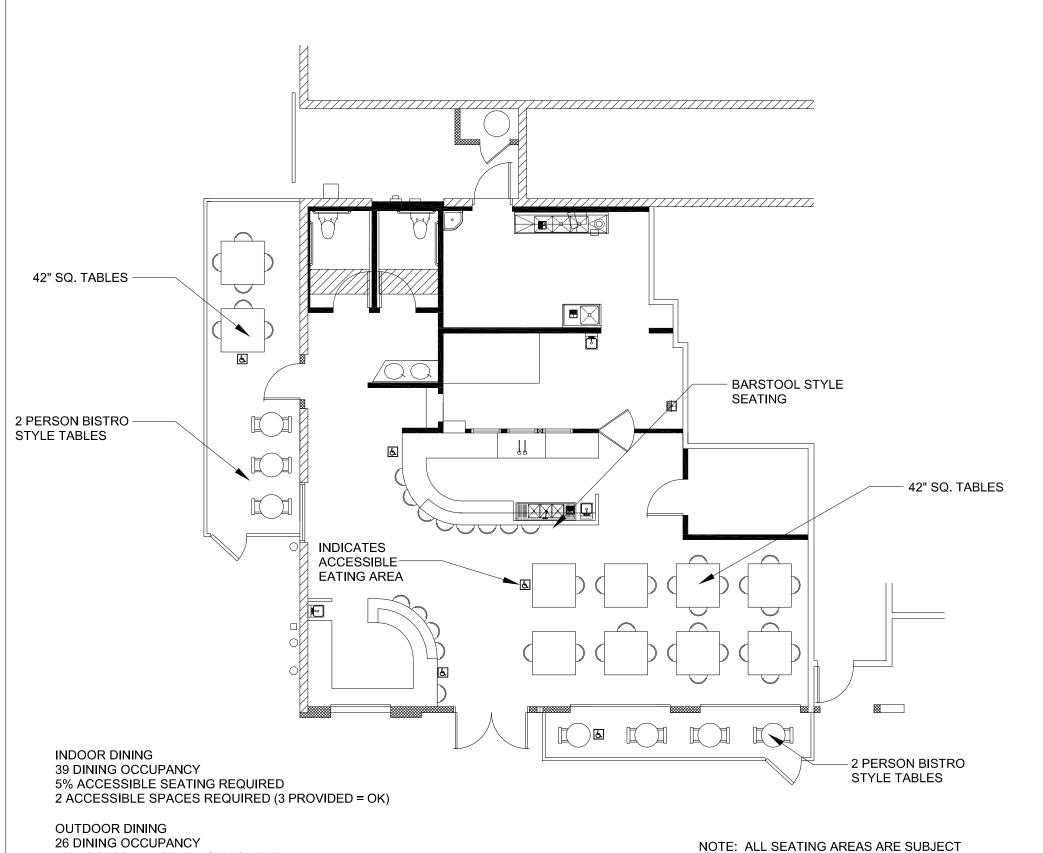
K PHOTO EXHIBIT
T-E SCALE: NTS

L PHOTO EXHIBIT
T-E SCALE: NTS

M PHOTO EXHIBIT
T-E SCALE: NTS

H PHOTO EXHIBIT
T-E SCALE: NTS





NOTE: ALL SEATING AREAS ARE SUBJECT TO FUTURE APPROVAL AND AGREEMENTS WITH THE CITY OF REDLANDS

01 REFERENCE SITE PLAN

A0.0 SCALE: 1" =10'

PROPOSED SEATING LAYOUT

A0.0 SCALE: 1/8" = 1'-0"

5% ACCESSIBLE SEATING REQUIRED 2 ACCESSIBLE SPACES REQUIRED (2 PROVIDED = OK)

INCORPORATED

1177 IDAHO ST, SUITE 200A REDLANDS, CALIFORNIA 92374 Ph. (909) 499-0058

This plan / design may not be copied, reproduced or assigned to any third party without the written consent of Higginson Architects, Inc.

Copyright 2021

CONSULTANT:

CLIENT:

BRUNCH CLUB
INTERIOR REMODEL
19 N. 5TH STREET
REDLANDS, CA. 92373

APPROVALS:

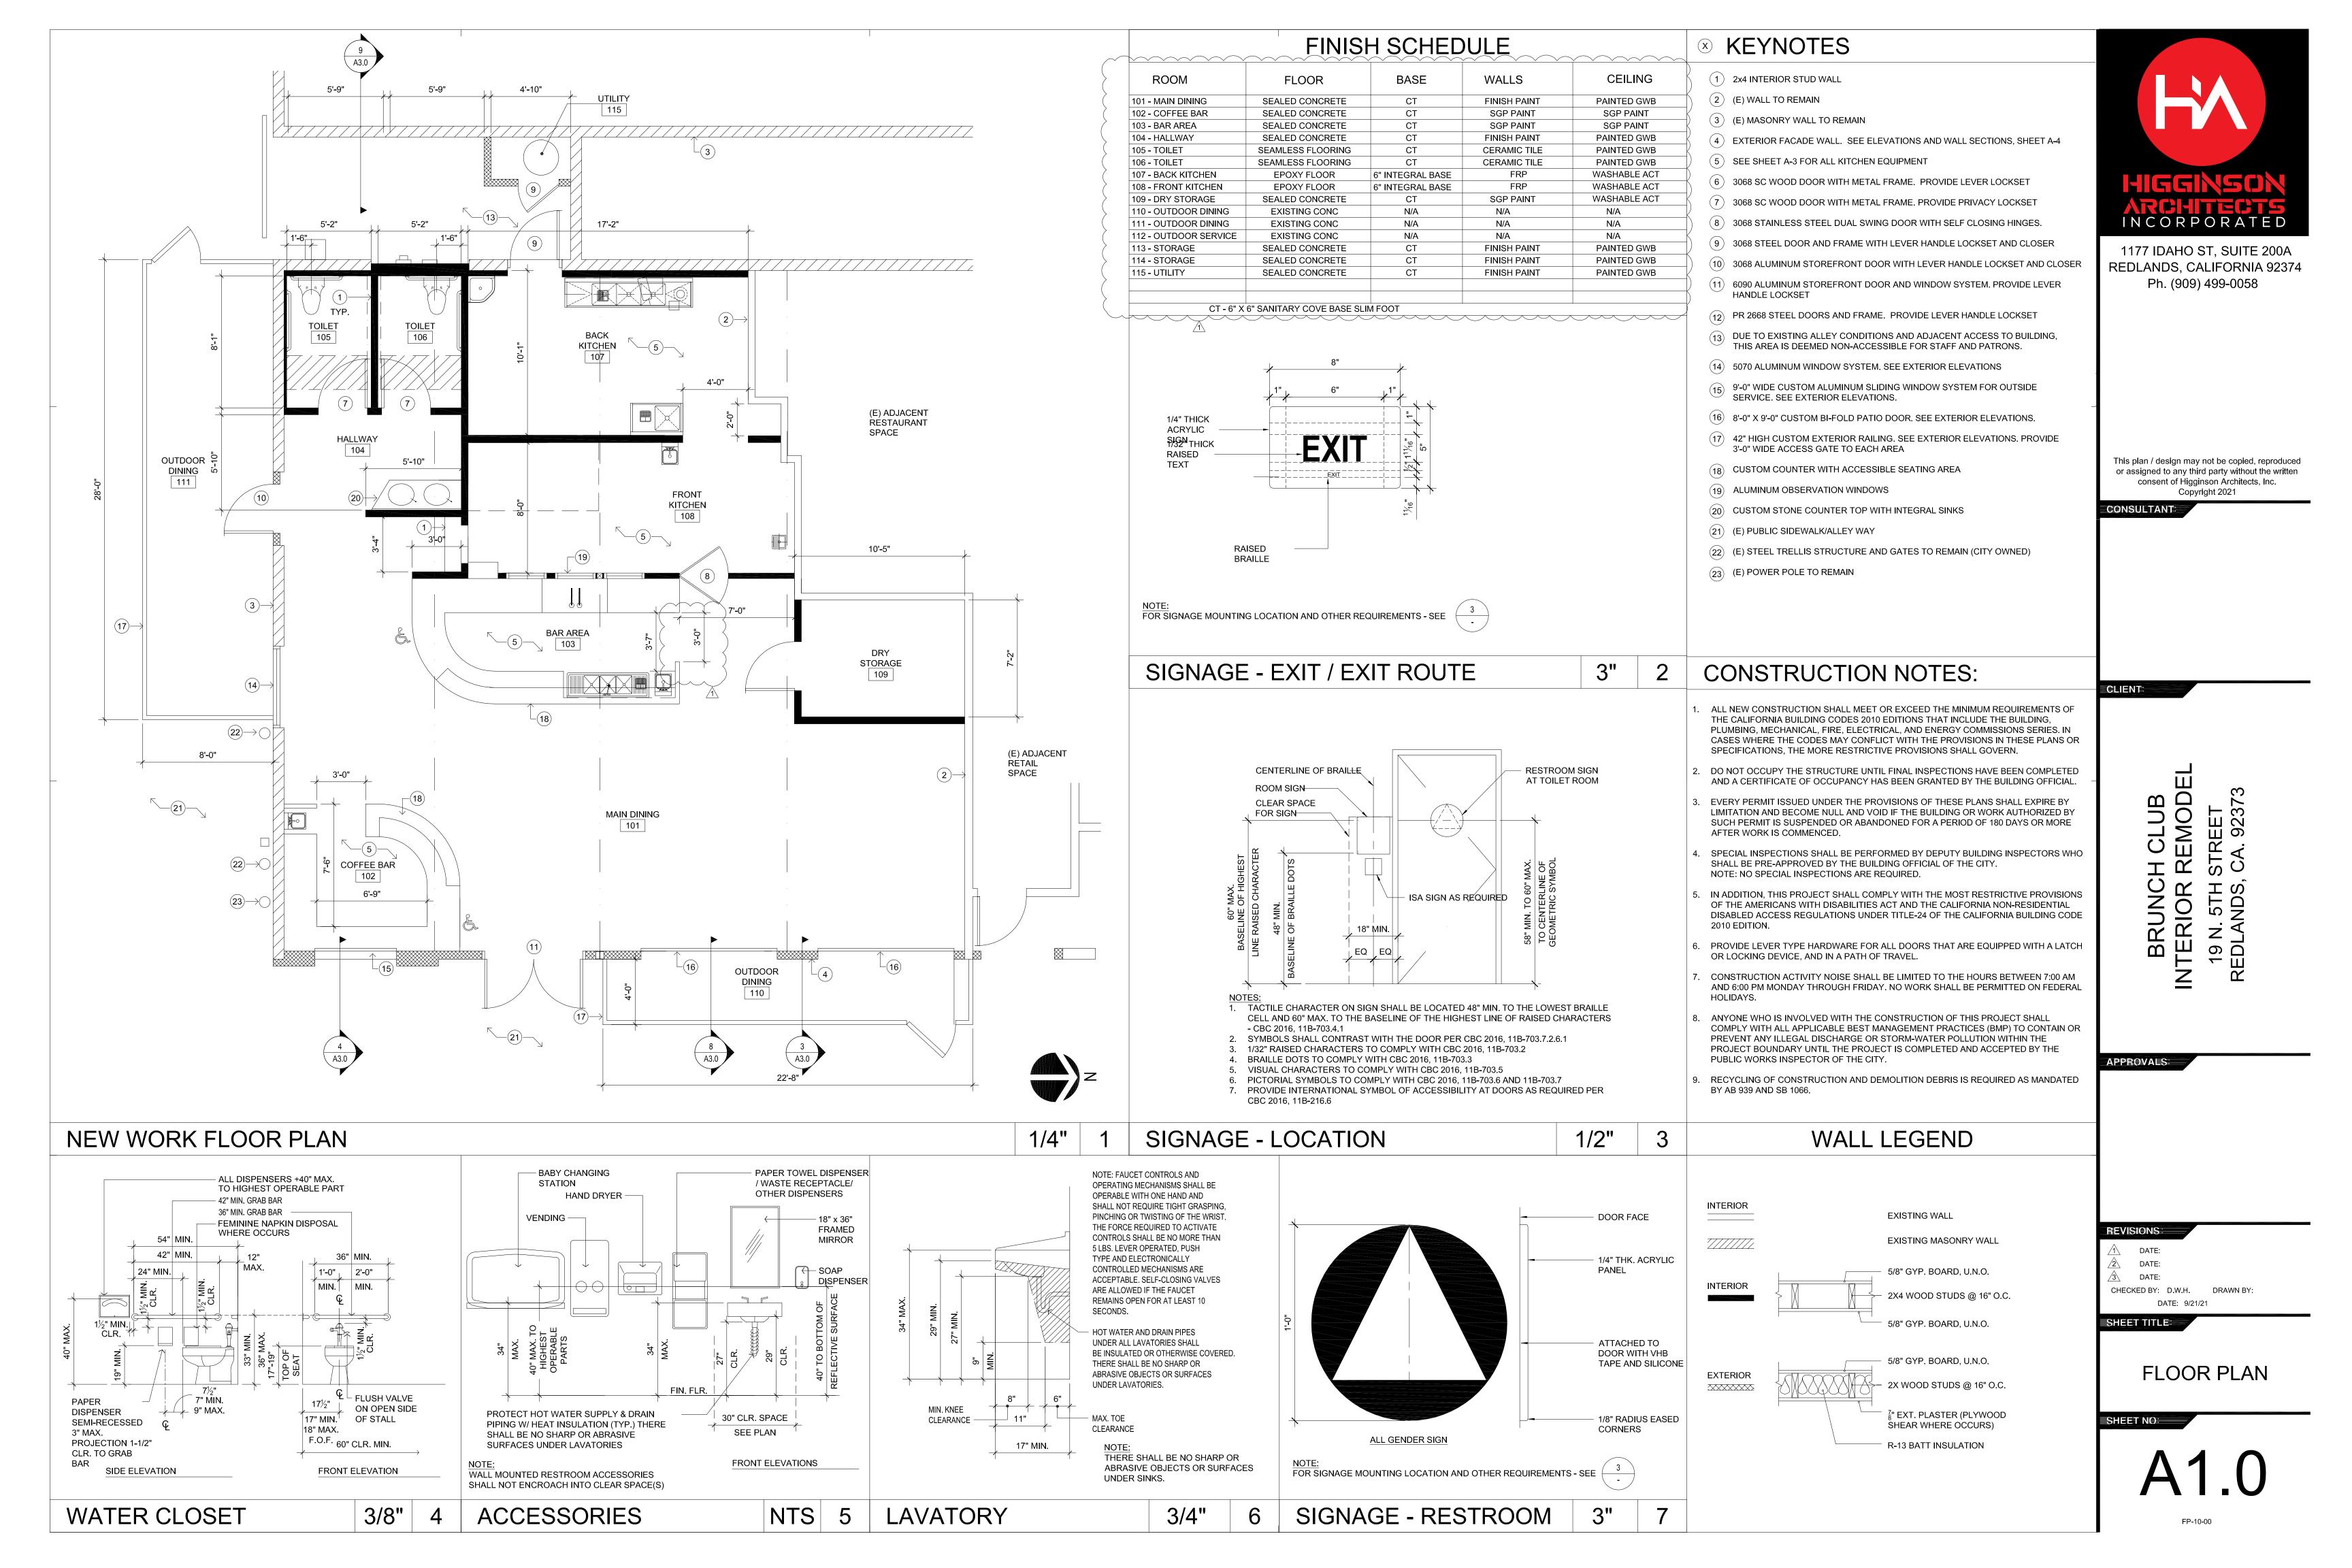
DATE: CHECKED BY: D.W.H. DRAWN BY:

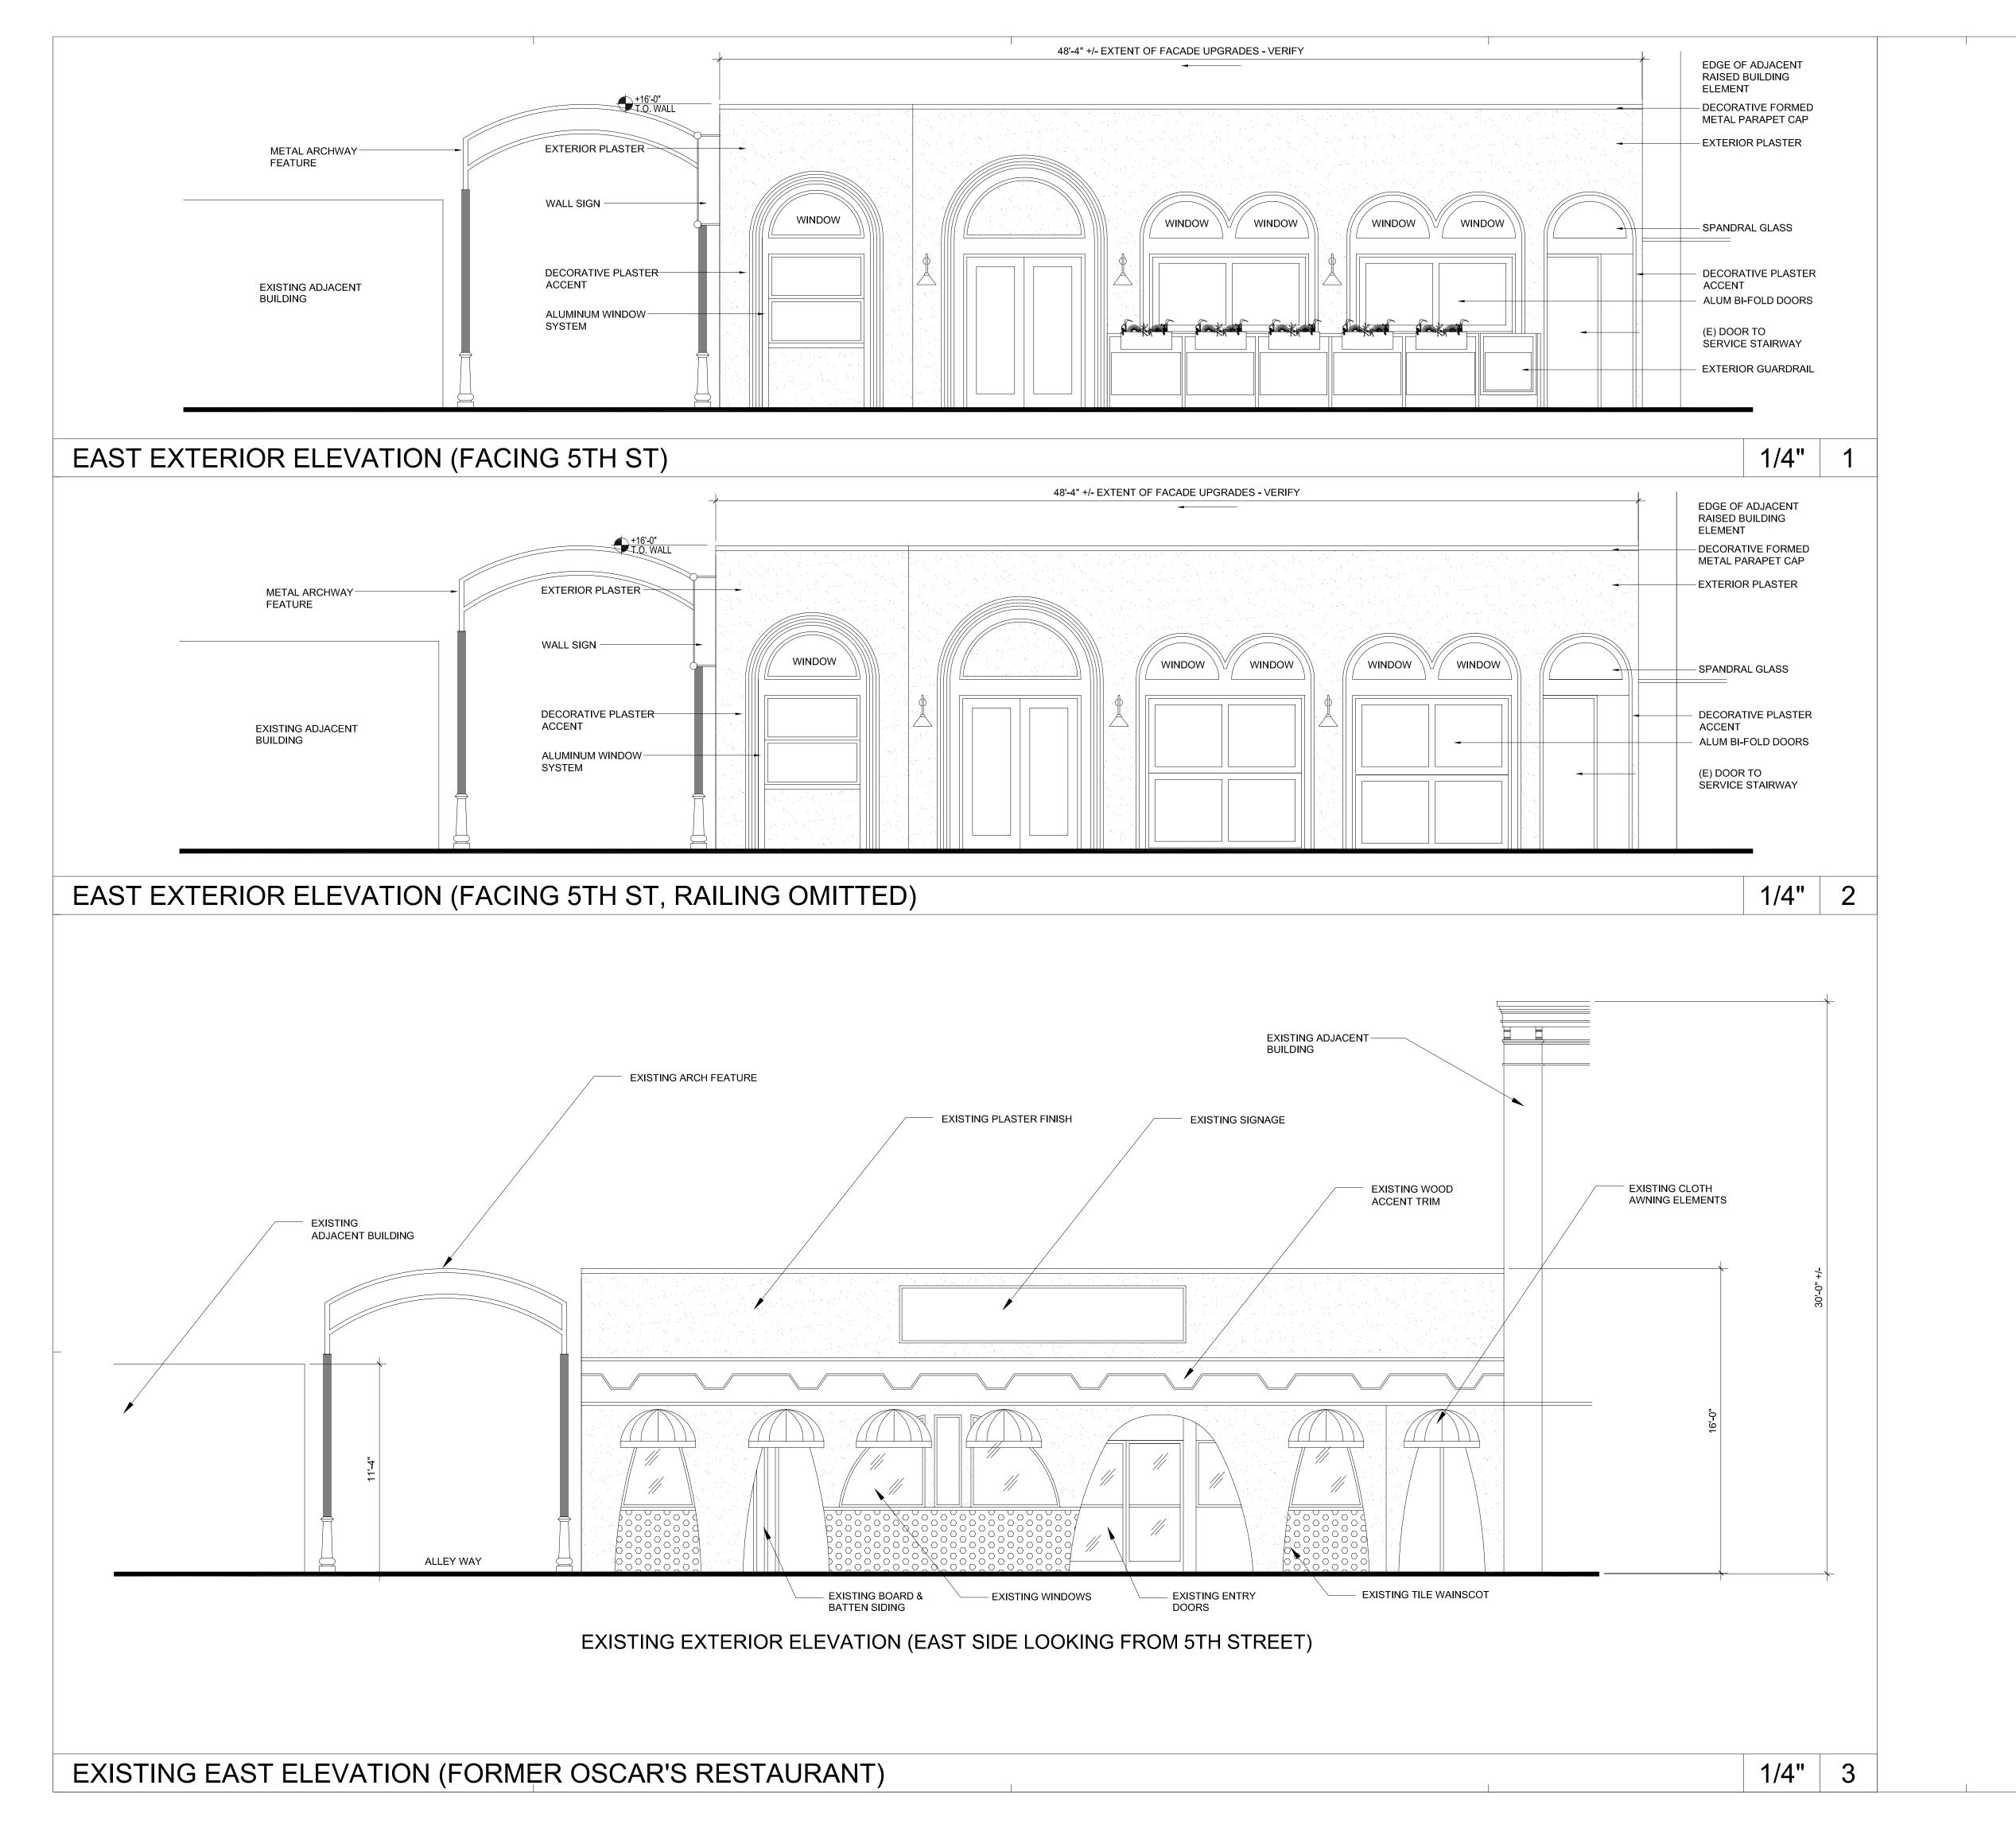
SHEET TITLE

SITE PLAN & SEATING LAYOUT

DATE: 9/21/21

FP-12-00_HISTORICAL







This plan / design may not be copied, reproduced or assigned to any third party without the written consent of Higginson Architects, Inc.

Copyright 2021

CONSULTANT:

CLIENT:

BRUNCH CLUB
INTERIOR REMODEL
19 N. 5TH STREET
REDLANDS, CA. 92373

APPROVALS:

DATE:
DATE:
DATE:

OHECKED BY: D.W.H. DRAWN BY:

DATE: 9/21/21

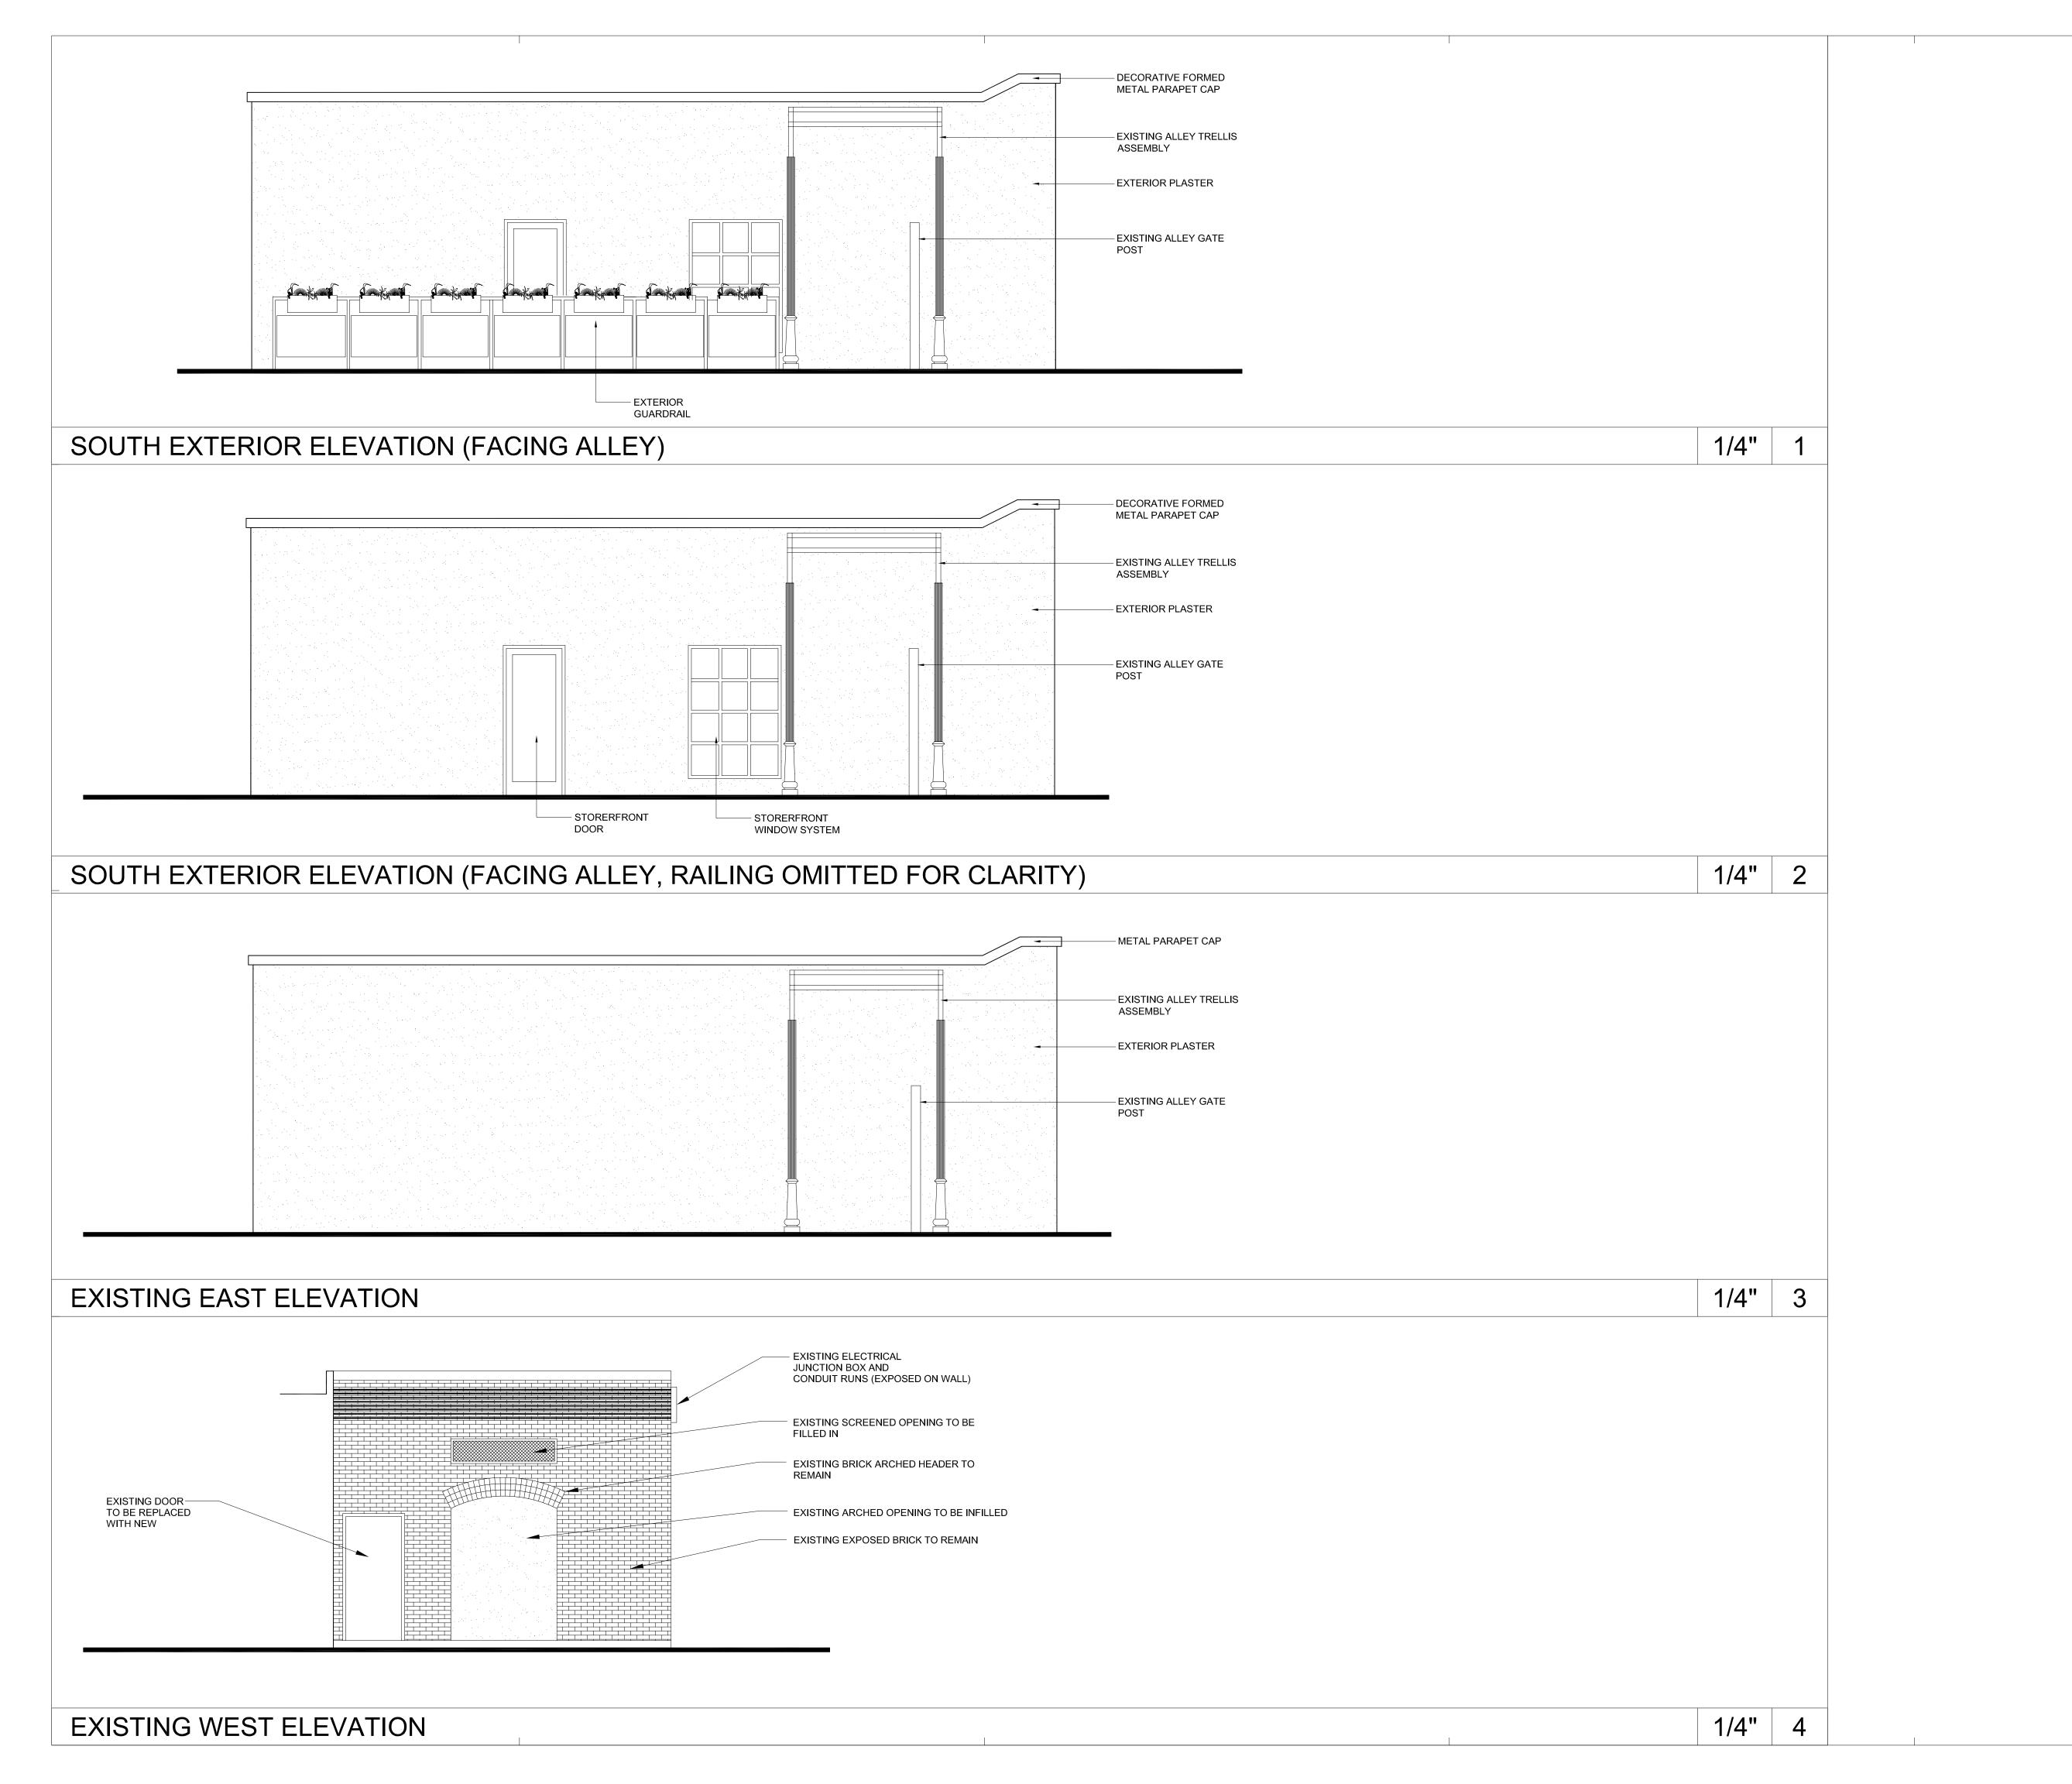
SHEETTITLE

ELEVATIONS

HEET NO:

A3.0

FP-12-00_HISTORICAL





This plan / design may not be copied, reproduced or assigned to any third party without the written consent of Higginson Architects, Inc.

Copyright 2021

CONSULTANT:

CLIENT:

BRUNCH CLUB
INTERIOR REMODEL
19 N. 5TH STREET
REDLANDS, CA. 92373

APPROVALS:

REVISIONS:

DATE:

DATE:

DATE:

DATE:

CHECKED BY: D.W.H. DRAWN BY:

SHEETTITLE

ELEVATIONS

SHEET NO:

A3.1

FP-12-00_HISTORICAL

RESOLUTION NO. 2022-06

A RESOLUTION OF THE HISTORIC AND SCENIC PRESERVATION COMMISSION OF THE CITY OF REDLANDS APPROVING CERTIFICATE OF APPROPRIATENESS NO. 642 FOR A FAÇADE REMODEL AND EXTERIOR IMPROVEMENTS TO AN EXISTING BUILDING LOCATED AT 19 NORTH FIFTH STREET (FORMERLY OSCAR'S MEXICAN RESTAURANT). THE EXISTING BUILDING SHARES THE 5,900 SQUARE-FOOT PARCEL (APN: 0171-121-10-0000) WITH HISTORIC RESOURCE NO. 33 LOCATED AT 24 E. STATE STREET.

WHEREAS, David Kelly, has submitted an application for Certificate of Appropriateness No. 642 for a façade remodel of a building located at 19 North Fifth Street on the same parcel as the historic Buster building (Historic Resource No. 33) located at 24 East State Street. The project is located in the General Commercial (C-3) District (APN: 0169-281-39-0000); and

WHEREAS, notice of this Historic and Scenic Preservation Commission public hearing for the Project was duly published in the Redlands Daily Facts by the Secretary to the Historic and Scenic Preservation Commission; and

WHEREAS, on February 3, 2022, the Historic and Scenic Preservation Commission held a public hearing and considered the staff report, oral report, the testimony and the written evidence submitted by and on behalf of the applicant and by members of the public; and

WHEREAS, Public Resources Code Sections 15331 (Historical Resource Restoration/Rehabilitation) and 15301 (Existing Facilities) provide for exemption from the California Environmental Quality Act, there is no substantial evidence of any potentially significant impacts, and the project qualifies for this exemption.

NOW, THEREFORE, BE IT RESOLVED BY THE HISTORIC & SCENIC PRESERVATION COMMISSION OF THE CITY OF REDLANDS AS FOLLOWS:

<u>Section 1.</u> The proposed project is exempt from the California Environmental Quality Act per Section 15331 for Historical Resource Restoration/Rehabilitation and Section 15301 Existing Facilities, and there is no substantial evidence of any potentially significant environmental impacts.

<u>Section 2.</u> This Certificate of Appropriateness is hereby approved subject to the conditions of approval contained in Exhibit A attached hereto.

Section 3. This Resolution shall become effective upon adoption.

ADOPTED, SIGNED AND APPROVED this 3rd day of February, 2022.

	Kurt Heidelberg, Chair
	Historic & Scenic Preservation Commission
ATTEST:	
	_
Linda McCasland, Secretary	
Redlands, hereby certify that the forego	ic Preservation Commission Secretary of the City of bing resolution was duly adopted by the Historic and
2022, by the following vote:	gular meeting thereof held on the 3rd day of February,
2022, by the following vote.	
AVEG	
AYES: NOES:	
ABSENT:	
ABSTAIN:	
	Linda McCasland, Secretary
	Historic & Scenic Preservation
	Commission

EXHIBIT A DEVELOPMENT SERVICES DEPARTMENT PLANNING DIVISION

CONDITIONS OF APPROVAL FOR CERTIFICATE OF APPROPRIATENESS NO. 642

Date of Preparation: January 25, 2022

Historic and Scenic Preservation

Commission Date: February 3, 2022 Applicant: David Kelly

Location: 19 North Fifth Street

Conditions of Approval:

- 1. This approval is for Certificate of Appropriateness No. 642 for a façade remodel and exterior improvements to an existing building located at 19 North Fifth Street (formerly Oscar's Mexican Restaurant). The existing building shares the 5,900 square-foot parcel (APN: 0171-121-10-0000) with Historic Resource No. 33 located at 24 E. State Street.
- 2. All plans submitted to the City as part of this Certificate of Appropriateness application shall reflect the plans approved on February 4, 2022 and shall comply with all provisions of the Redlands Municipal Code.
- 3. Outdoor seating areas will require separate permits and agreements prior to any construction or encroachment into the right-of-way.
- 4. Unless construction has commenced pursuant to a building permit, or a time extension is granted in accordance with Code, this application shall expire in eighteen (18) months from the approval date.

Note: This project can be extended by staff per Section 2.62.200(K) for a period not to exceed thirty-six (36) months.

5. The applicant for this permit, and its successors and assigns, shall defend, indemnify and hold harmless the City of Redlands, and its elected officials, officers, agents and employees, from and against any and all claims, actions, and proceedings to attack, set aside, void or annul the approval of this permit by the City, or brought against the City due to acts or omissions in any way connected to the applicant's project that is the subject of this permit. This indemnification shall include, but not be limited to, damages, fees, costs, liabilities, and expenses incurred in such actions or proceedings, including damages for the injury to property or persons, including death of a person, and any award of

attorneys' fees. In the event any such action is commenced to attack, set aside, void or annul all, or any, provisions of this permit, or is commenced for any other reason against the City for acts or omissions relating to the applicant's project, within fourteen (14) City business days of the same, the applicant shall file with the City a performance bond or irrevocable letter of credit (together, the "Security") in a form and in an amount satisfactory to the City, to ensure applicant's performance of its defense and indemnity obligations under this condition. The failure of the applicant to provide the Security shall be deemed an express acknowledgement and agreement by the applicant that the City shall have the authority and right, without objection by the applicant, to revoke all entitlements granted for the project pursuant to this permit. The City shall have no liability to the applicant for the exercise of City's right to revoke this permit.

6. The applicant shall not make any modifications or changes during construction that are in conflict or contrary to the project's approved site design, or building elevations without first consulting with the Development Services Director or his designee.

Loralee Farris, Principal Planner Historic Preservation Officer